

all heights, sizes and dimensions should be checked on site by the contractor before any work is put in hand.

figured dimensions should be taken in preference to scaling and any errors or omissions reported to the architect at once

This drawing has been prepared in accordance with the CDM (Construction Design and Management) and all foreseeable design risks to those involved or affected by construction have been avoided wherever possible

Materials Legend:

- 1: concrete interlocking roof tiles grey colour
- 2: Black UPVC rainwater downpipes and gutters
- 3: Charcoal Grey UPVC double glazed windows
- 4: Charcoal Grey UPVC double glazed doors and frames
- 5: Charcoal UPVC bi fold doors and curtain wall system
- 6: Rendered external wall finish
- 7: Timber/ Timber effect clad external wall finish
- 8: Flat roof finish
- 9: Glazed balcony system
- 10: Black/ Grey clad wall system
- 11: Blue brickwork wall
- 12: Roof light
- 13: charcoal grey rooflight
- 14: Bat tube opening
- 15: Raised ridge tiles for bat nesting

Proposed ground floor area = 100.6m²
Proposed first floor area = 85m²
Total area = 185.1m²

Rev	Date	By	Detail
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Drawing status

Planning

Client

Mr Stephens

Project/Location

High View
Scarlett Lake
Huntley
Nr Cheadle
Staffs



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Drawing title

PLANS ELEVATIONS AS PROPOSED

Scale[s]	Date	Drawn	Checked
1 : 100	10/06/15	Author	Checker
@A1			

Drawing number	Revision
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2971- 04



Side Elevation (North-West)

1 : 100



Front Elevation (North-East)

1 : 100




Side Elevation (South-East)

1 : 100




Rear Elevation (South-West)

1 : 100

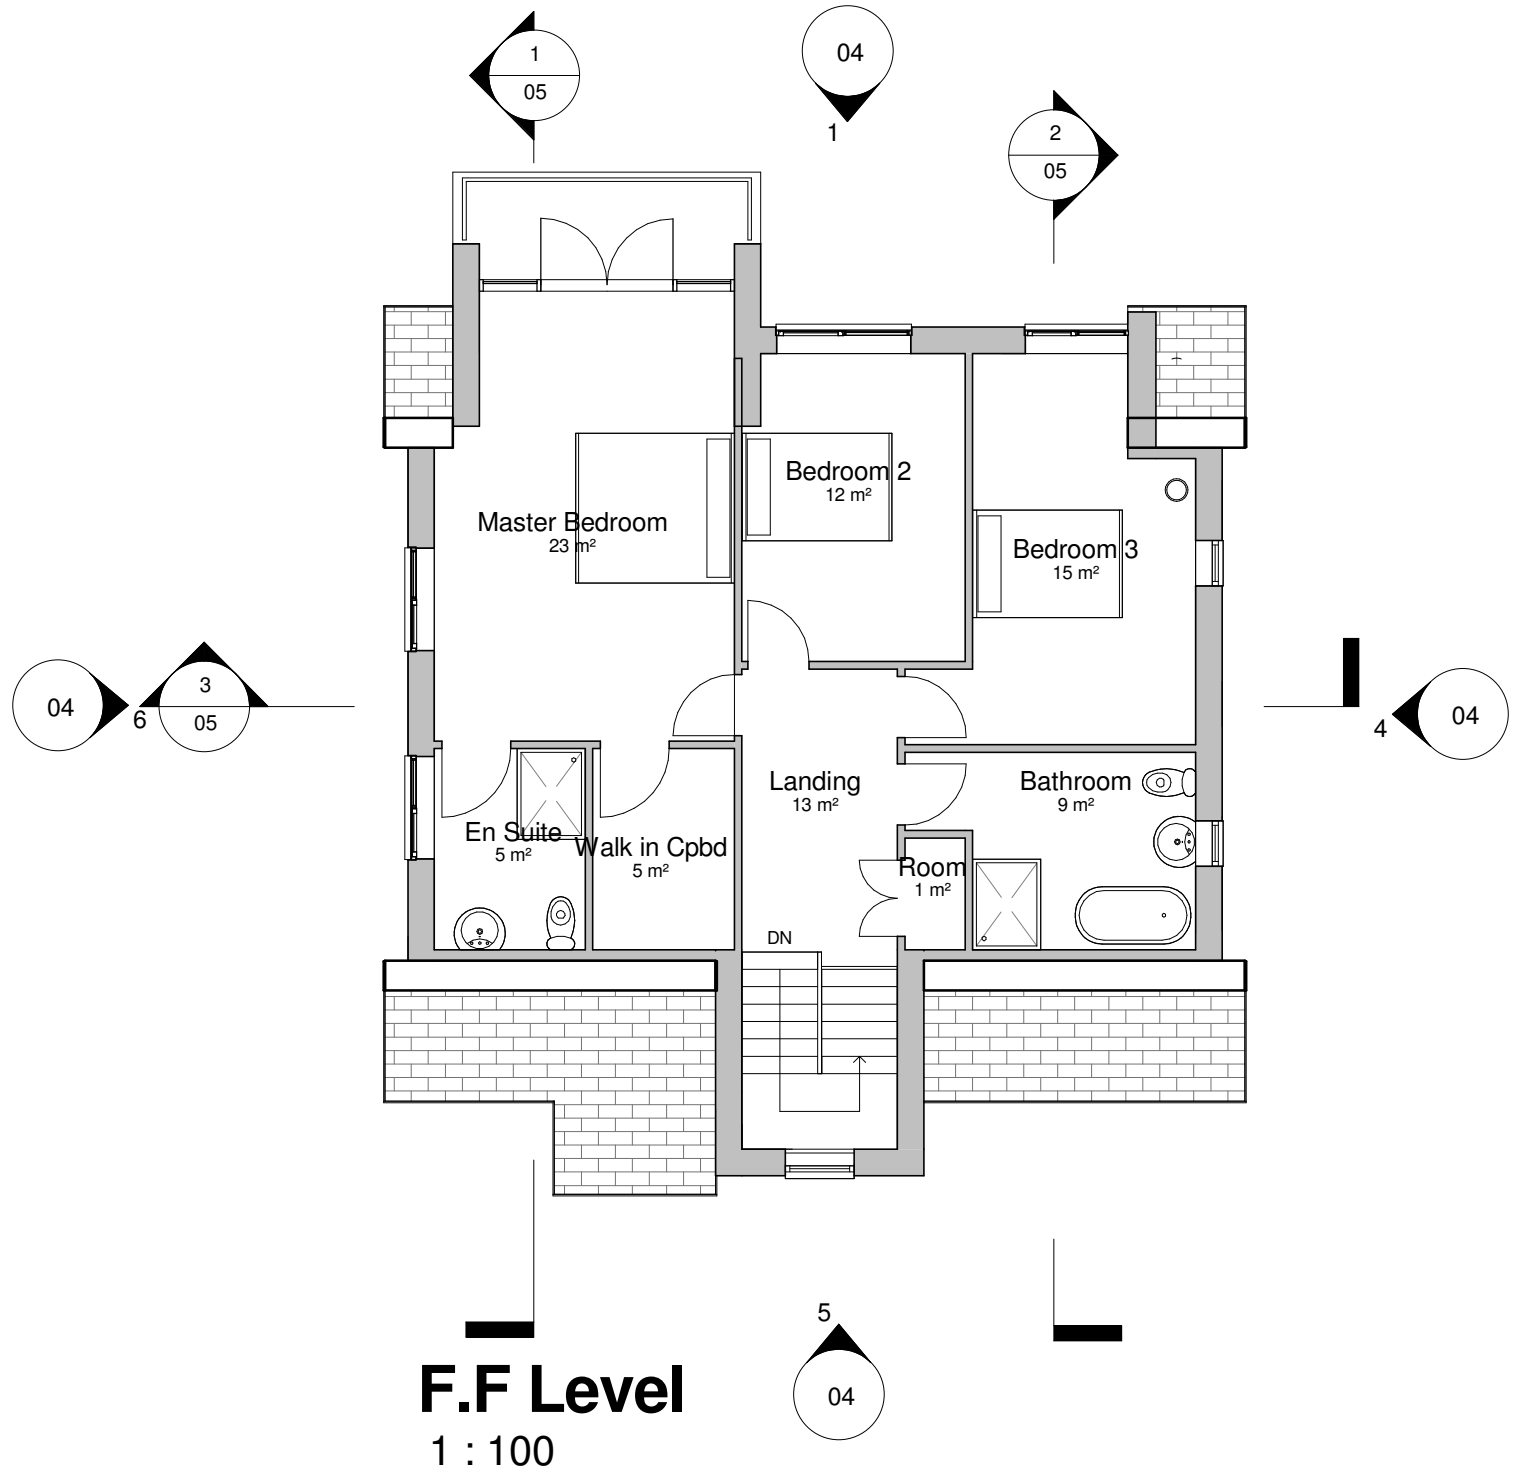

F.F Level

1 : 100

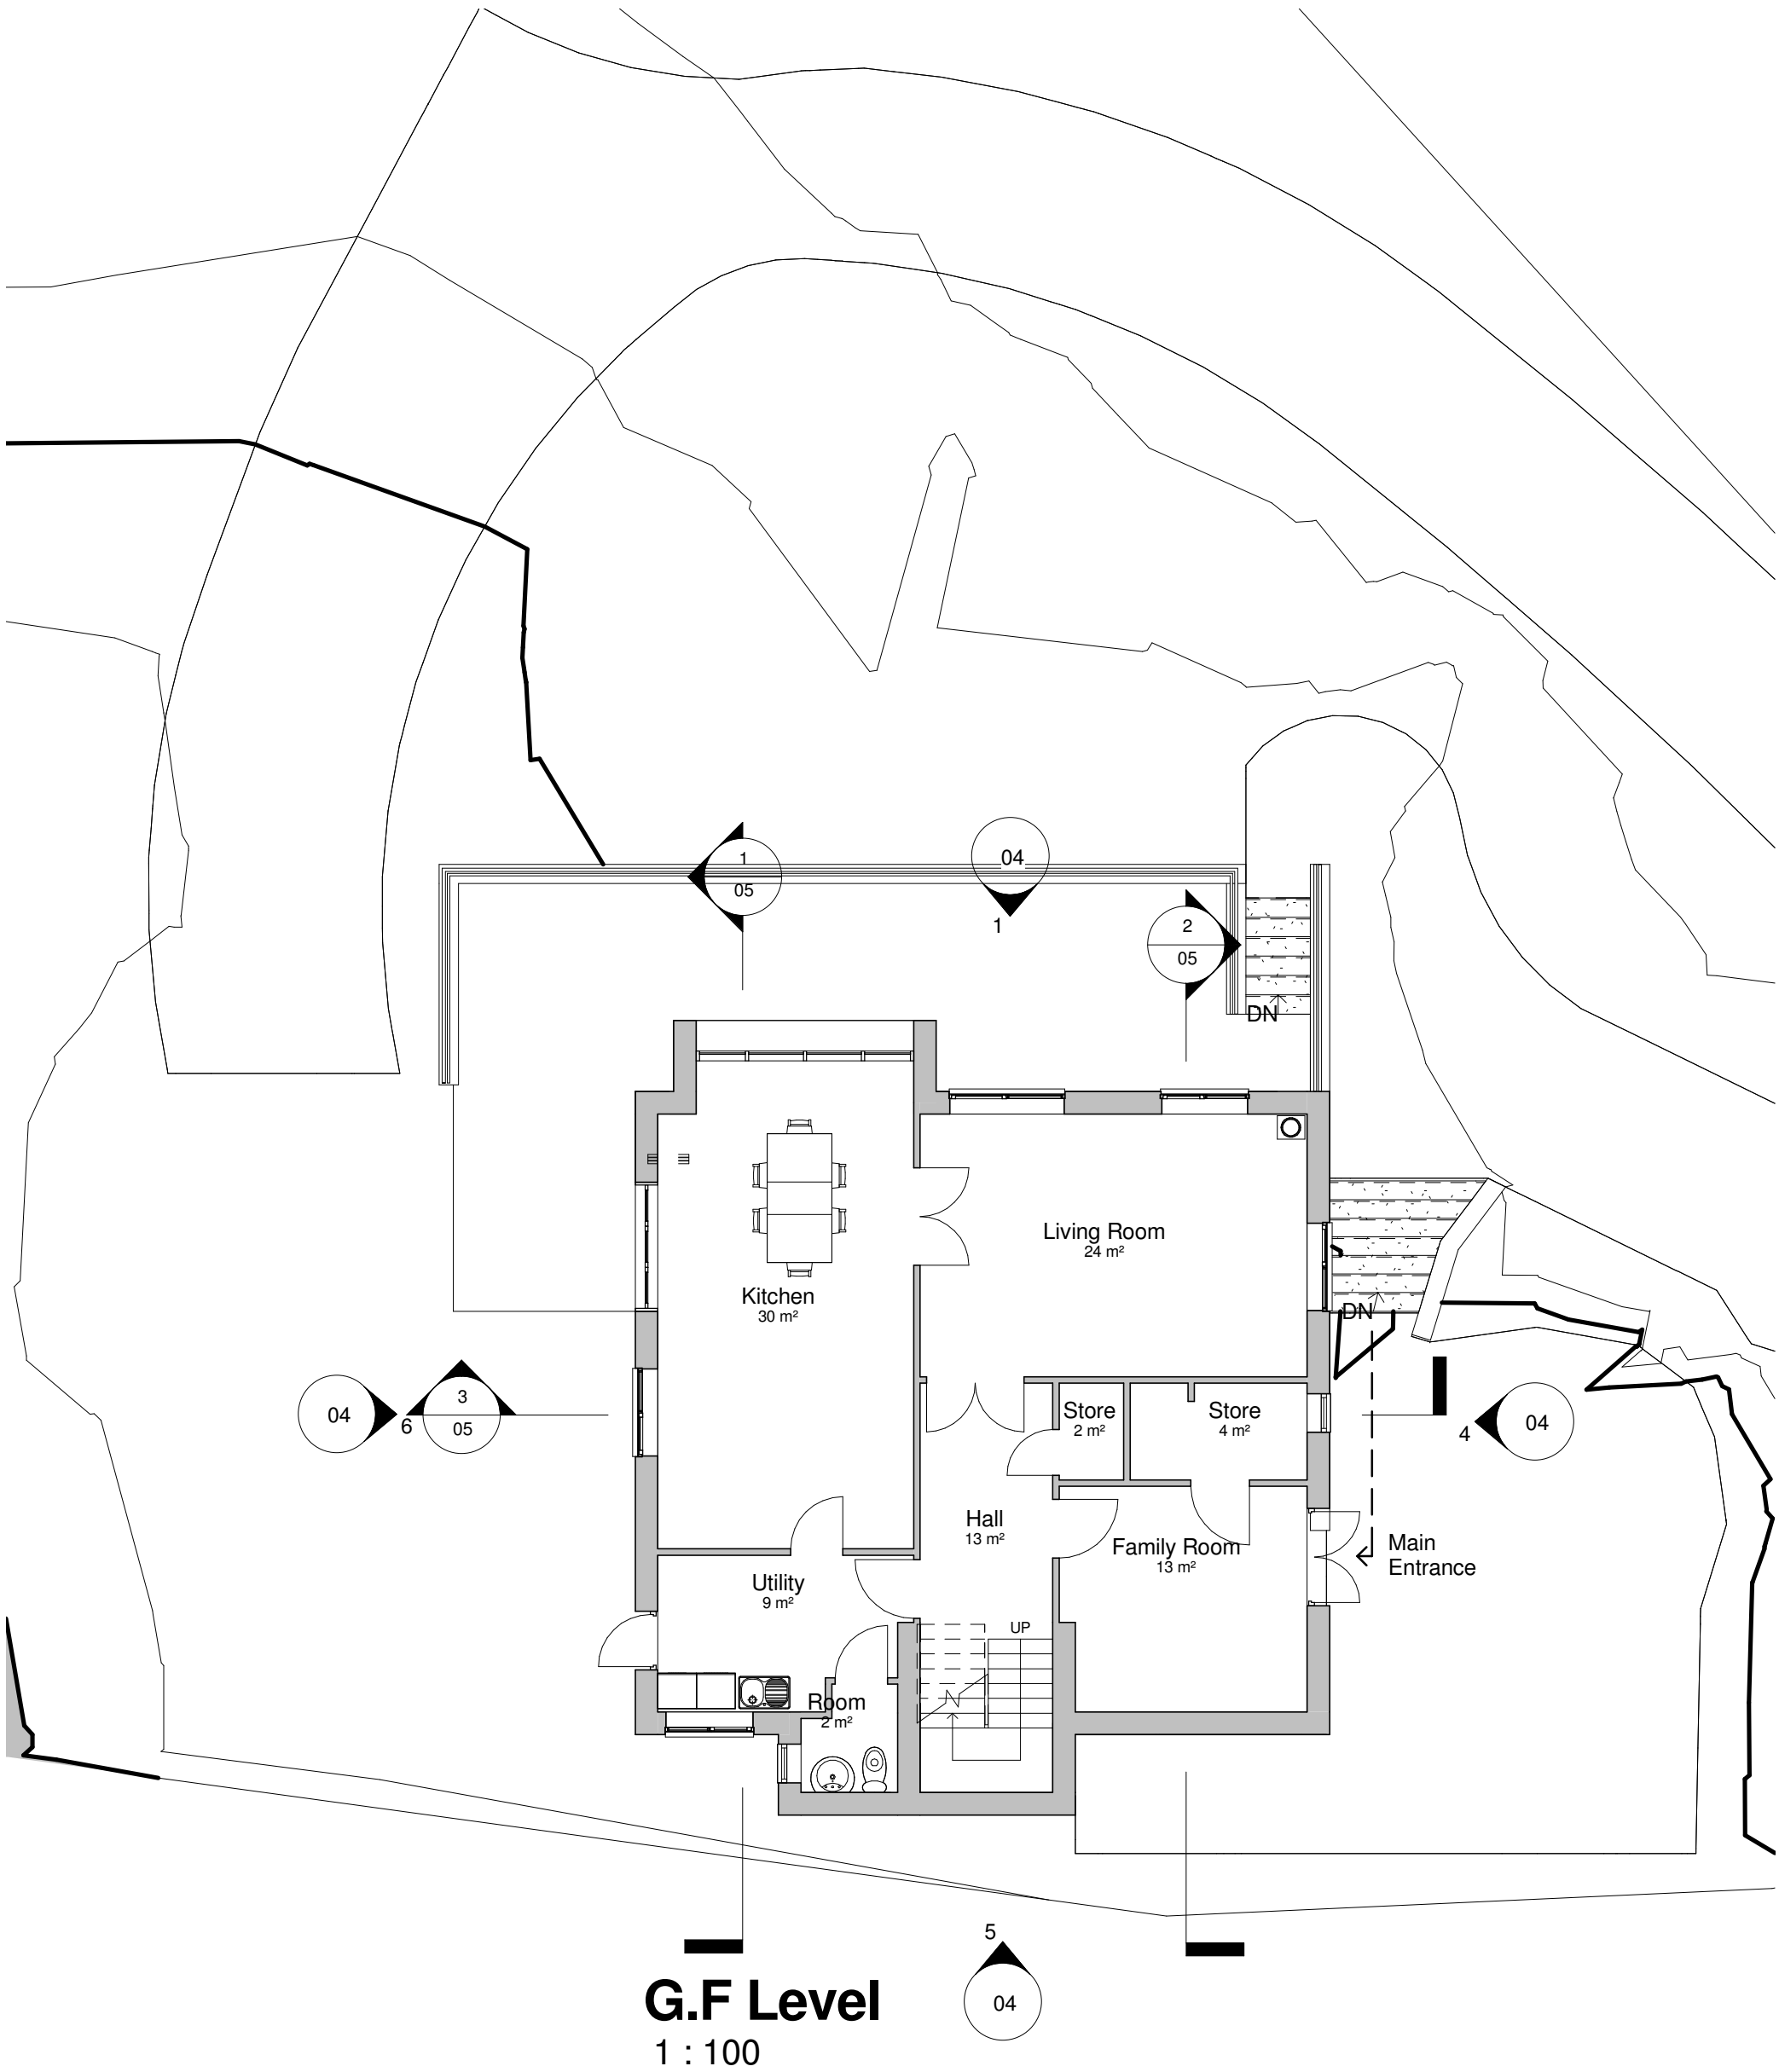

G.F Level

1 : 100

Scale 1 : 500

