




FLOOR PLAN

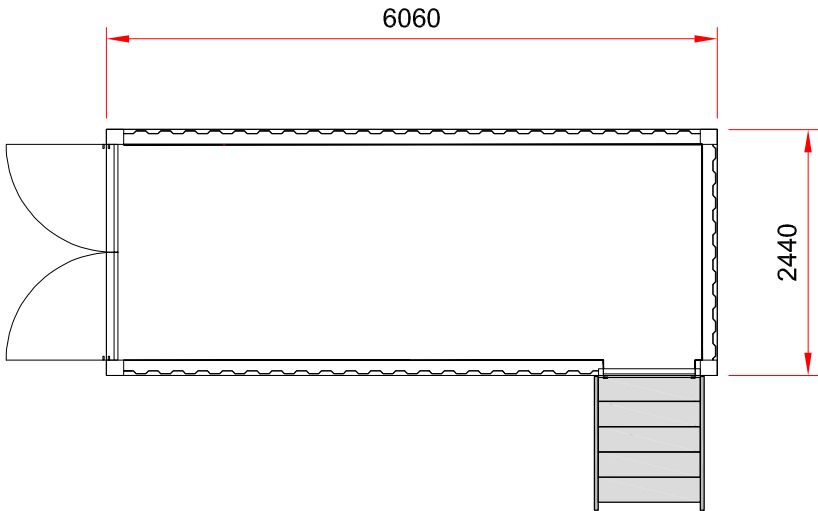

FRONT ELEVATION

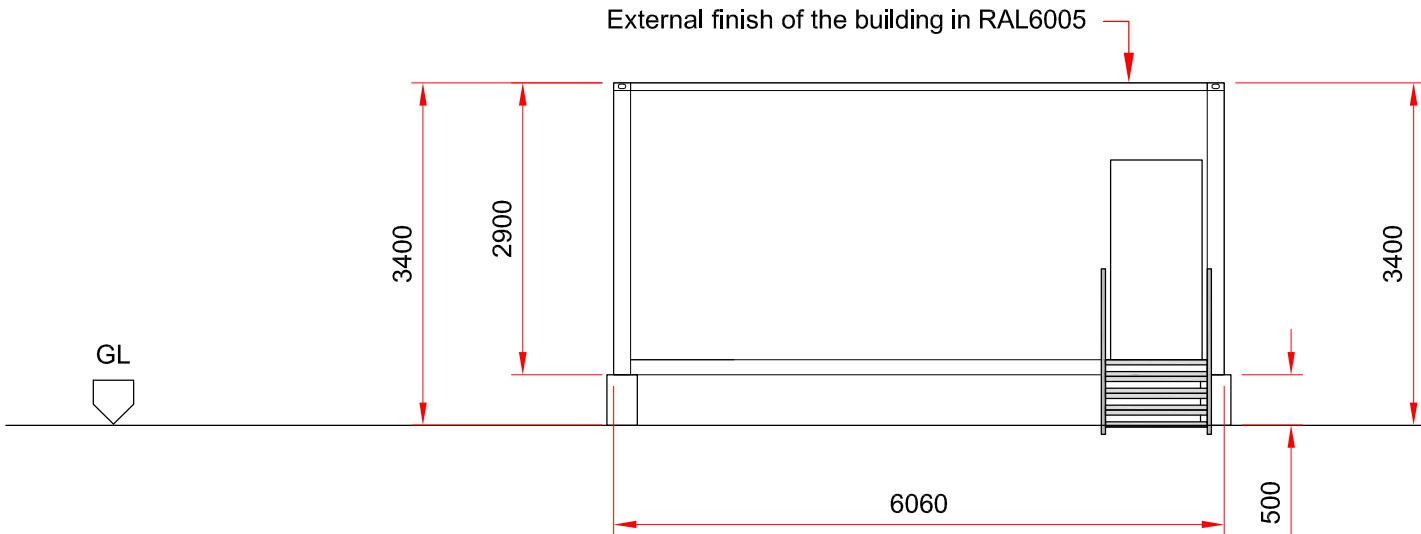

SIDE ELEVATION

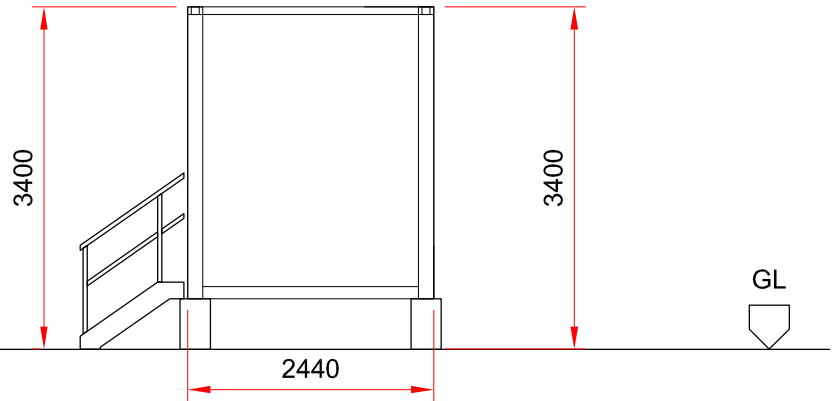

Notes:

1. All dimensions are in mm.
2. Based on Burnell drawing " Substation 2 CONTAINER/HOUSING" received on 29/01/15 for specific project GOODE-CROSS.
3. Substation building consists of steel base frame and wood floor.
4. Natural ground slope depends of the project and topography drawing, maximum elevations should be recalculated for each project.

Revisions:

STANDARD DETAIL

Rev	Date	Comments	Dwn	Chkd
C	16/03/15	Note 4 for standard detail added	AL	VL
B	09/03/15	Note 3 added	VL	AL
A	06/03/15	External finish colour RAL6005 added	VL	PR

Client:

Location:

Project: Groundmount System

Title: Transformer Substation Elevations & Plan

Dwn: VL Chkd: AS Scale: 1:75@A3 Date: 03/03/15
Drg No.: GM-273 Rev: C



50 Great Sutton Street
London EC1V 0DF

T +44 (0)20 7549 1000
F +44 (0)20 7549 1001

www.solarcentury.com
info@solarcentury.com

Do not scale from this drawing. Do not use any information without checking dimensions on site.
Check this drawing is the latest version. Do not reproduce all or part of this without prior consent.
E-mails of this drawing shall not be used as a contract document unless subsequently validated
by a handcopy and issue sheet.
All work and materials to be to current codes of practice and British Standards unless stated
otherwise.